

TYPE	WIDTH	HEIGHT	DESCRIPTION
D1	3'0" (914)	7'0" (2100)	T.W. FRAMED, T.W. PLY PUSH DOOR
D2	3'0" (914)	7'0" (2100)	T.W. FRAMED, COMMERCIAL PLY FLUSH DOOR
D3	2'0" (610)	7'0" (2100)	- DO - MISC. DEFECTS rectified
W1	5'0" (1524)	4'0" (1220)	COUNTRY WOOD FRAME & GLAZED SHUTTERS
W2	3'0" (914)	4'0" (1220)	- DO -
V1	2'0" (610)	2'0" (610)	COUNTRY WOODEN FRAMED, GLASS LOUVERED VENTILATOR
W1A	7'0" (2100)	4'0" (1220)	COUNTRY WOOD FRAME & GLAZED SHUTTERS

SPECIFICATION OF WORKS

FOUNDATION - R.C.C. RAFT FOUNDATION OVER A BED OF 1:4:8 SAND-FILLING

SUPER STRUCTURE - 15 THK. & 230 THK. WALLS IN C.M. 1:3 WITH PLASTER 1:3:6 M.C. MIX ADEQUATELY REINFORCED

R.C.C. WORKS - R.C. COLUMNS, BEAMS, SLABS, LINTELS & SUNSHADES IN 1:2:4 MIX ADEQUATELY REINFORCED

FLOORING - MOSAIC FLOORING

WEATHERING COURSE - ONE SET OF BRICK JELLY LIMB CONCRETE MIXED WITH CRUDE OIL PAINTED & LAID TO SLOPE

COLOR CODE REFERENCE

PROPOSED WORK SHOWN THUS

EXISTING ROAD SHOWN THUS

BOUNDARY LINE SHOWN THUS

SEWER LINE SHOWN THUS

EXISTING COMPOUND WALL

AREA STATEMENT

PLOT AREA = 4503.29 SQ. FT. (418.53 SQ. M)

GROUND FLOOR AREA = 1626.52 SQ. FT. (151.13 SQ. M)

FIRST, SECOND & THIRD FLOOR = 5052.53 SQ. FT. (468.35 SQ. M)

TOTAL = 6679.34 SQ. FT. (620.55 SQ. M)

PLOT COVERAGE = 37.03%

F.S.I. 1:4.8

NON F.S.I. (ELECTRICAL ROOM) = 40.78 SQ. FT. (3.78 SQ. M)

MMDA/B/EP/NO. 1

Com. Murahari B. 147/18/91

SIGNATURE OF OWNER

V. LAKSHMANAN
S.E. M.E. F.I.V.

SIGNATURE OF CLASS I LICENSED SURVEYOR NO. 415

PROPOSED RESIDENTIAL FLATS IN PLOT NO. 16, BLOCK NO. 12 AND T.S. NO. 18 - G/21, SURVEY NO. 6 (PART) VADA AGARAM, NELSON - MANICKA MUDALIAR ROAD, MADRAS-29.


FLOOR PLANS, ELEVATIONS, GATE, COMP. PERCOLATION TRENCH, SITE PLAN, KEY PLAN ETC.

JOB NO. DES. NO. C-01


SCALE - AS MENTIONED

DATE: 16.06.95

DRAWN:

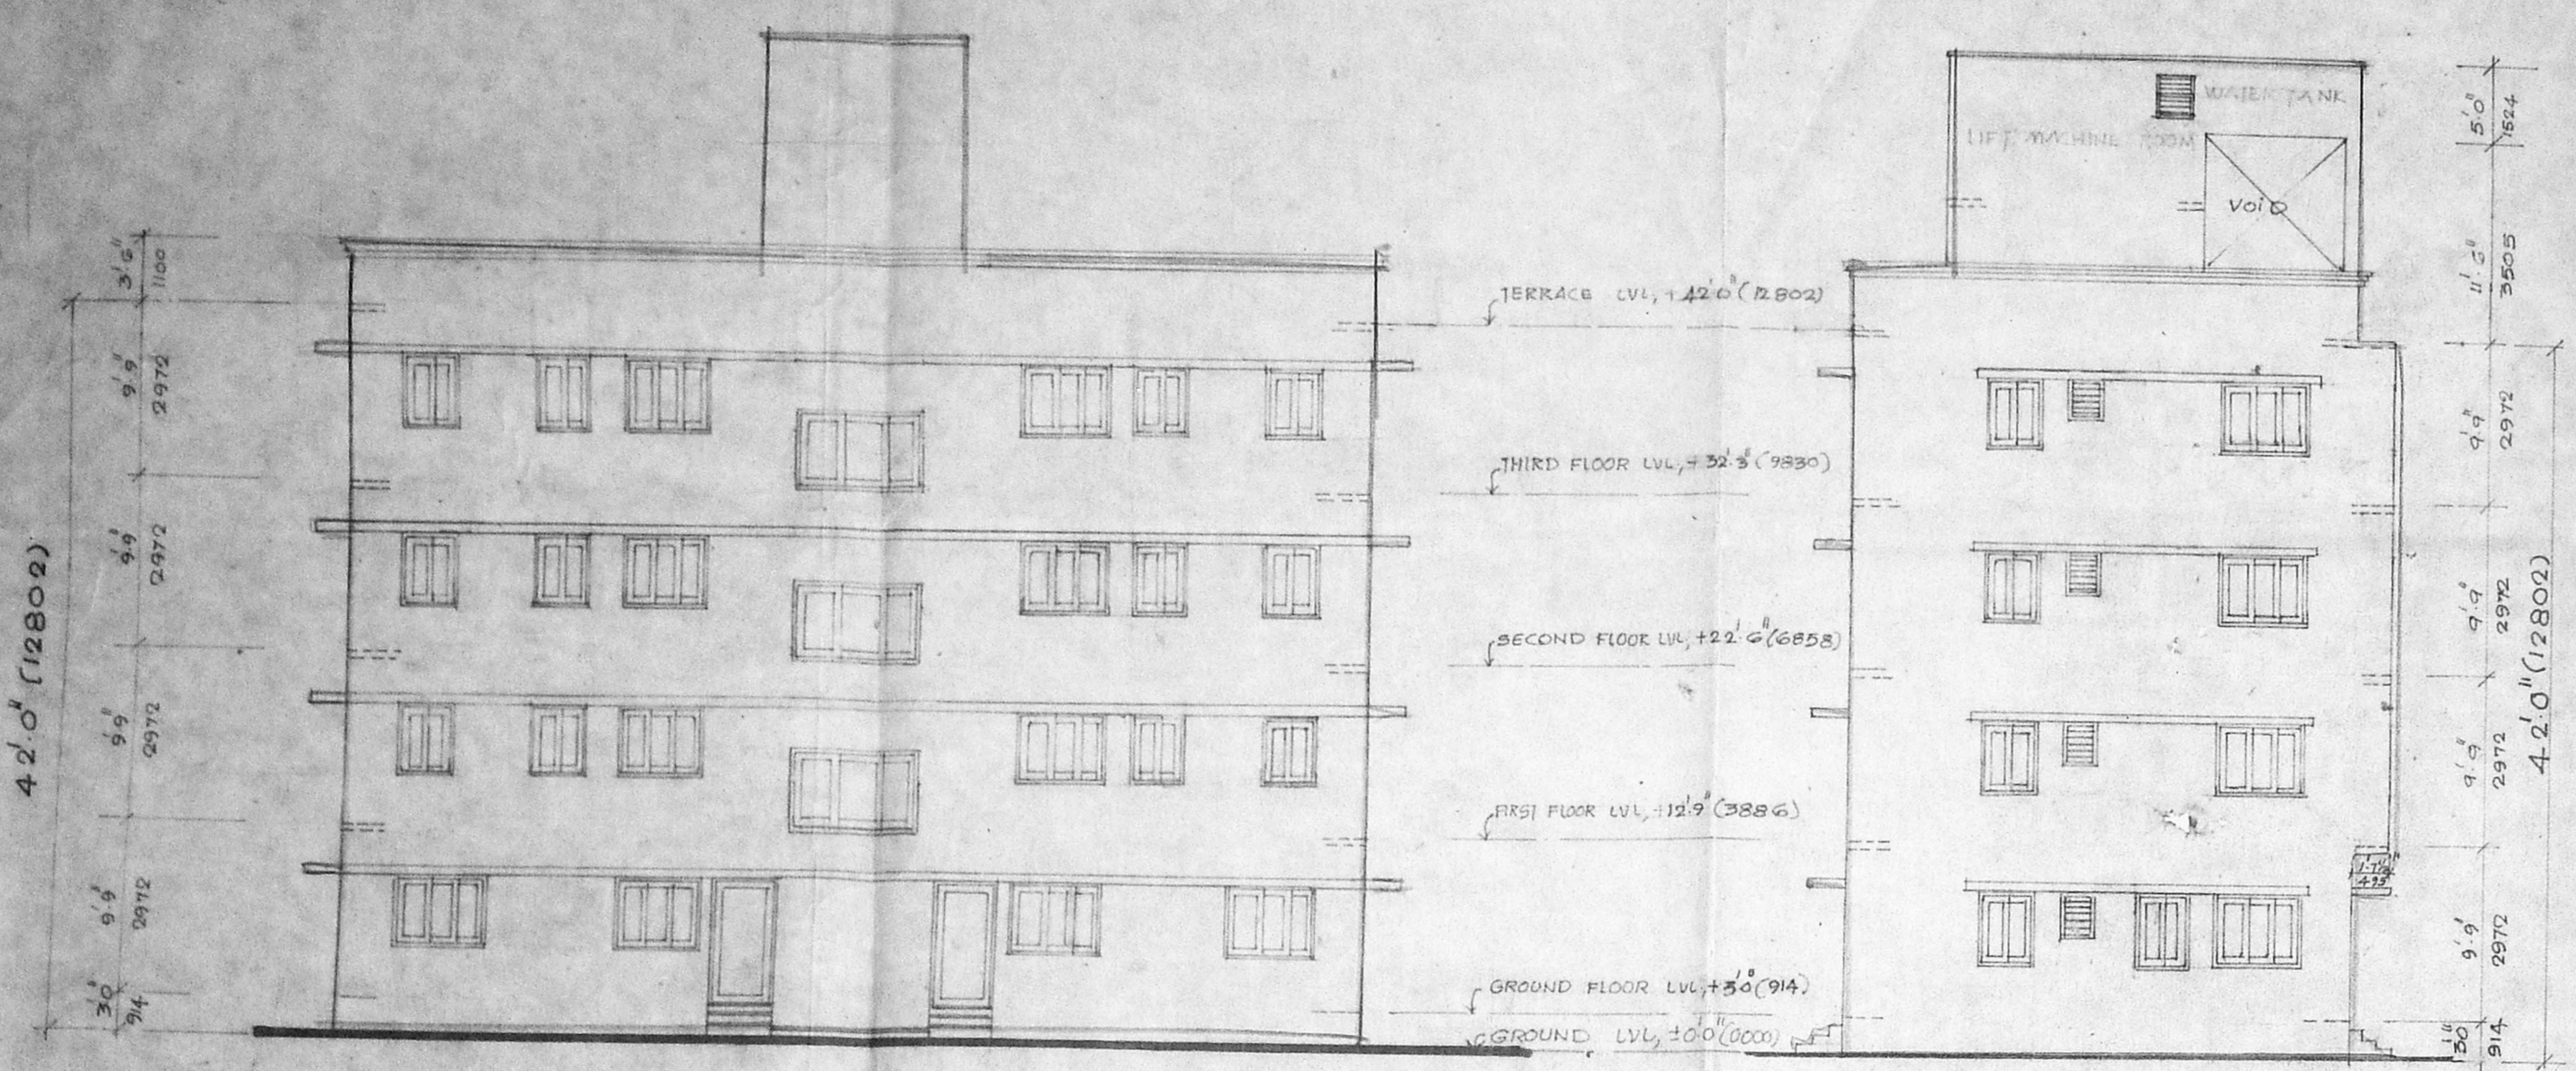

NORTH SIDE ELEVATION
SCALE = 1:100

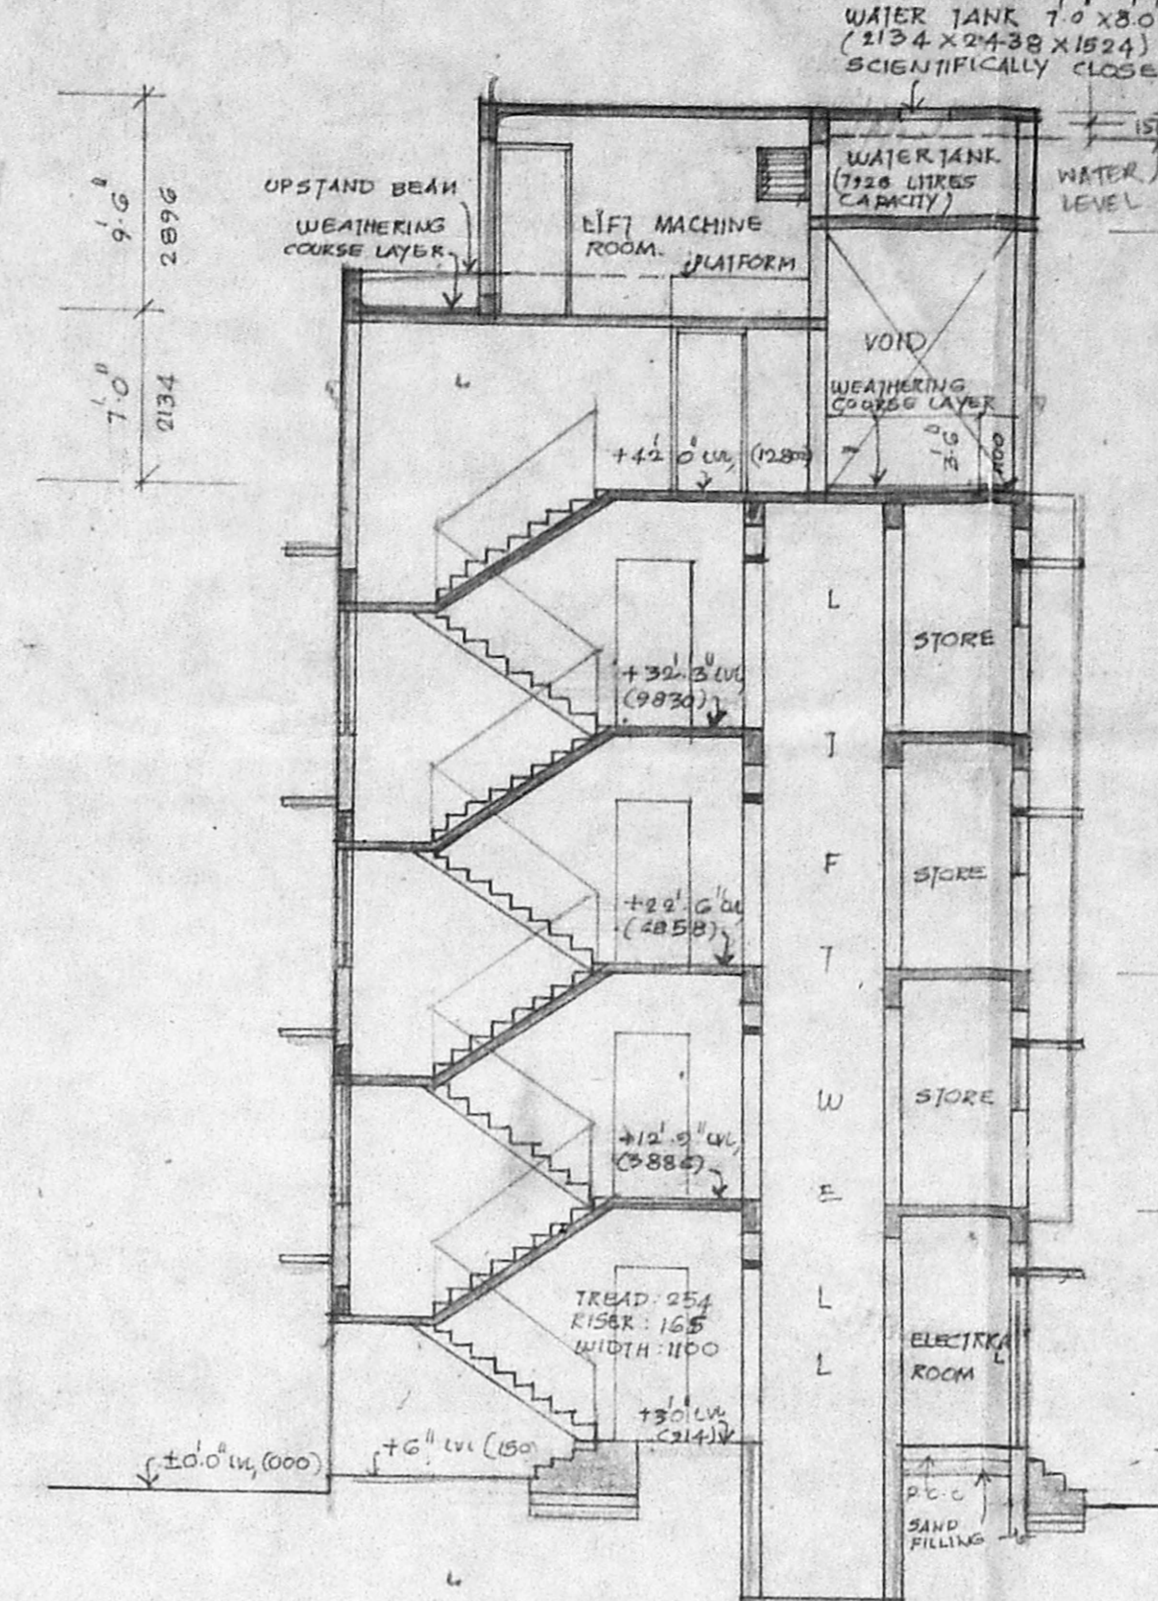

WEST SIDE ELEVATION
SCALE = 1:100


B/2002/3/635/95
Planning Permit No.

APPROVED
SUBJECT TO THE CONDITIONS IN THIS OFFICE LETTER.


No. B/167/2/95
Date: 13.06.95

FOR MEMBER SECRETARY
MADRAS METROPOLITAN
DEVELOPMENT AUTHORITY
MADRAS - 600 008.


SECTION-AA
SCALE = 1/8" = 1'0" (1:100)

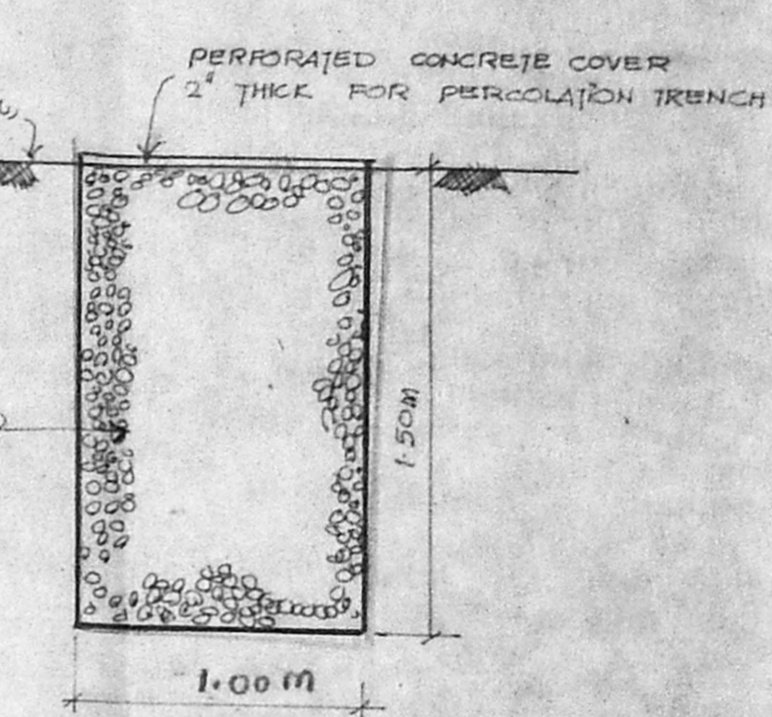


SECTION THROUGH PERCOLATION TRENCH
SCALE = 1:25

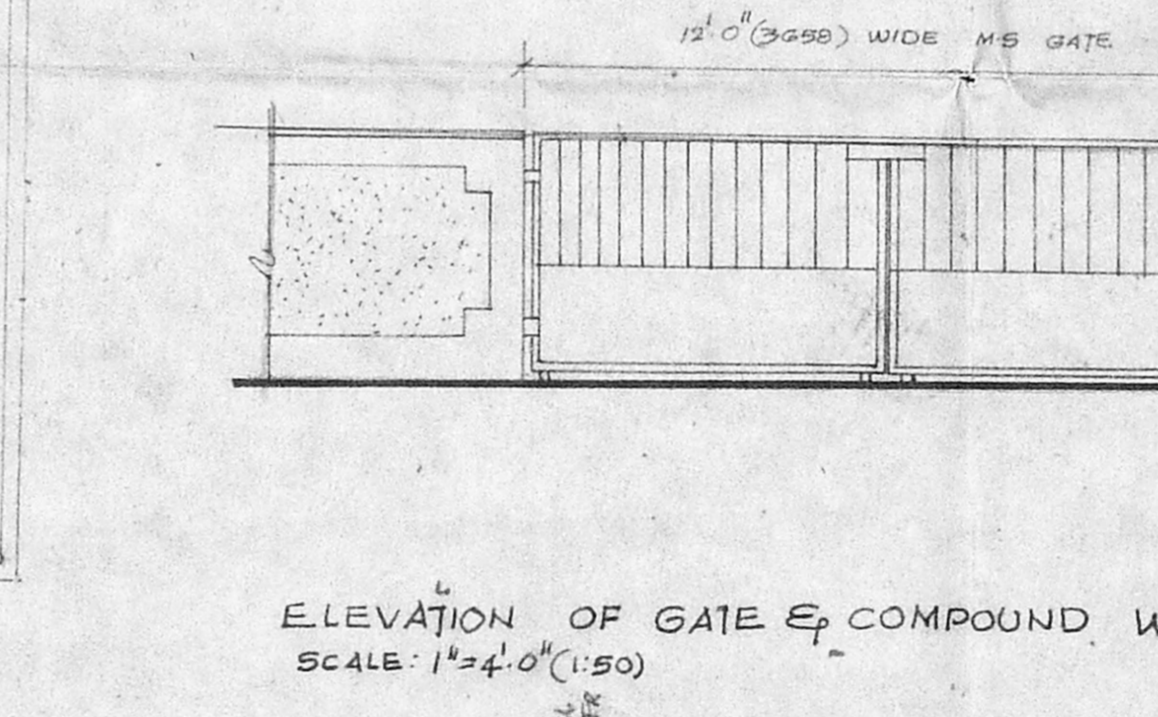


ELEVATION OF GATE & COMPOUND WALL
SCALE = 1/2" = 1'0" (1:50)

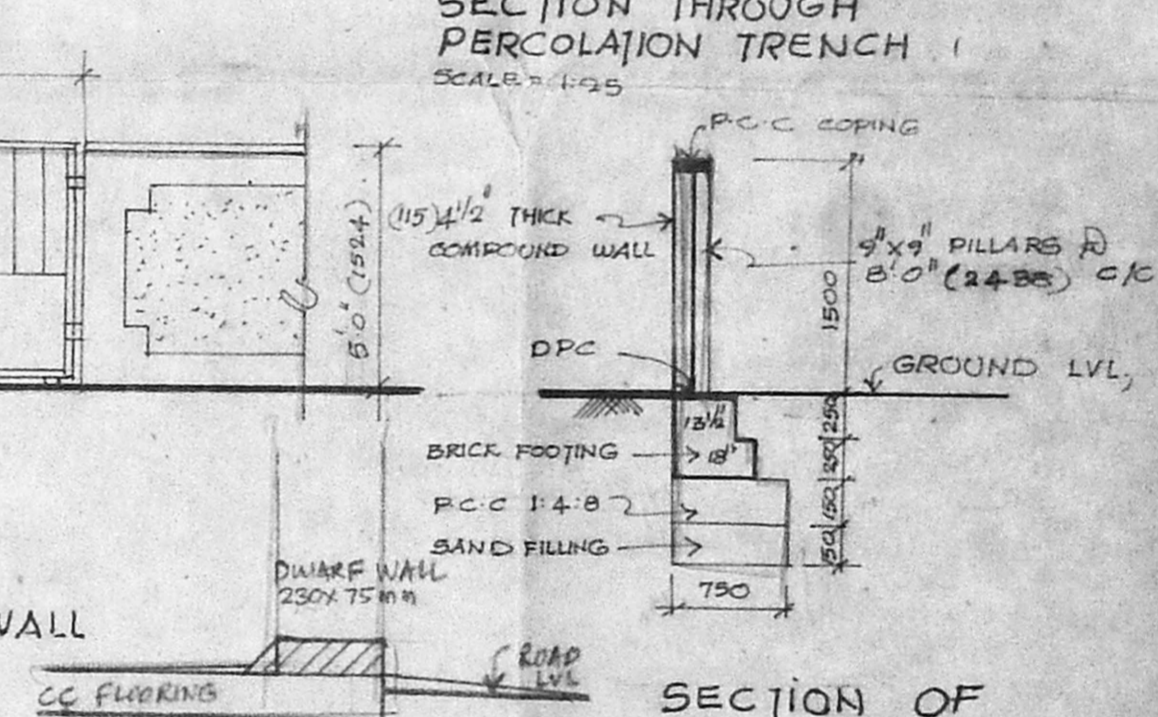


SECTION OF COMPOUND WALL
SCALE = 1:50

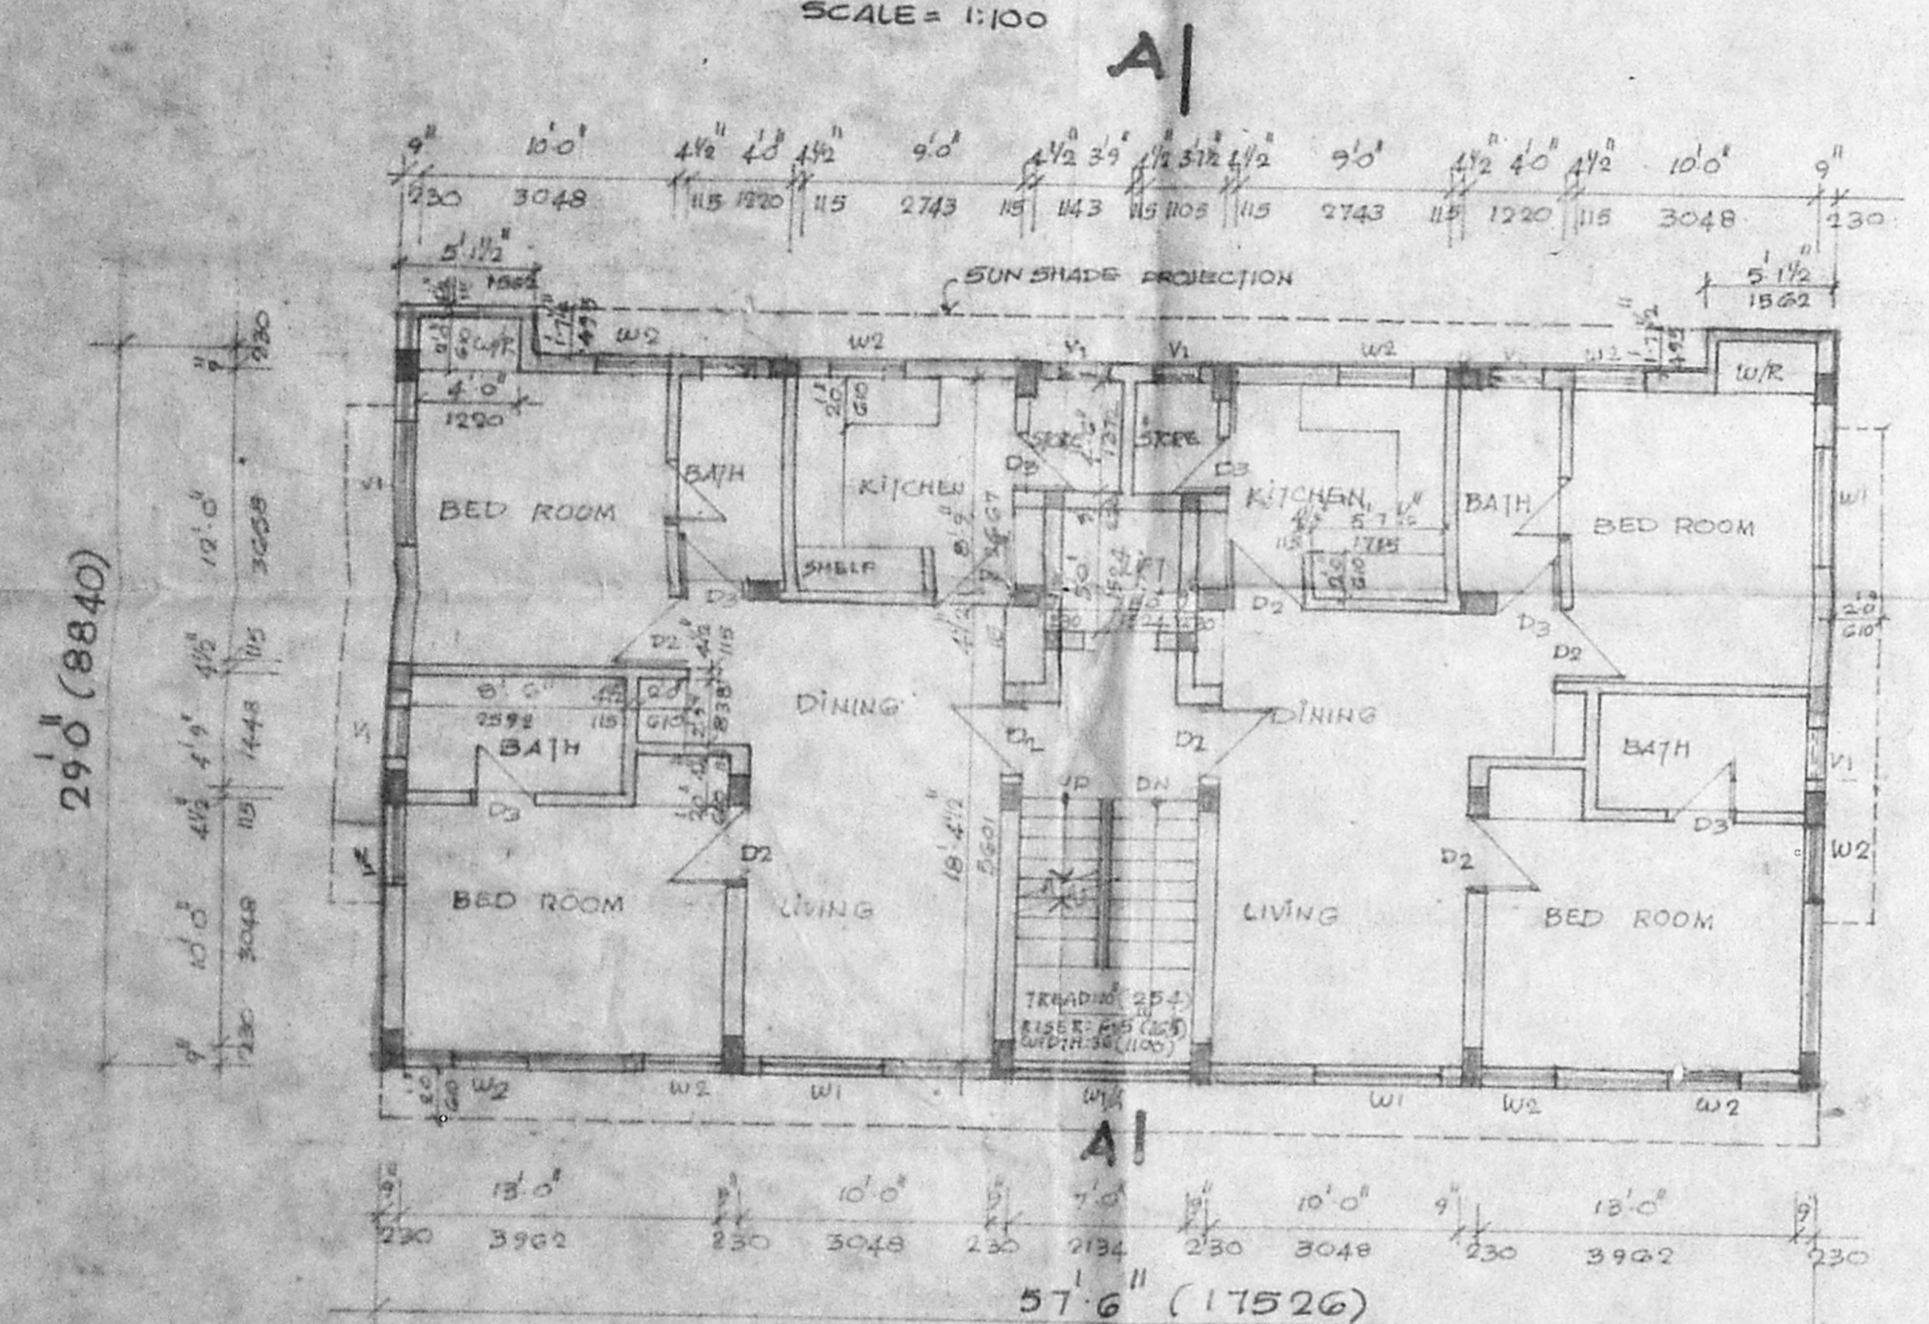


TYPICAL FLOOR PLAN (I, II & III)
SCALE = 1/8" = 1'0" (1:50)

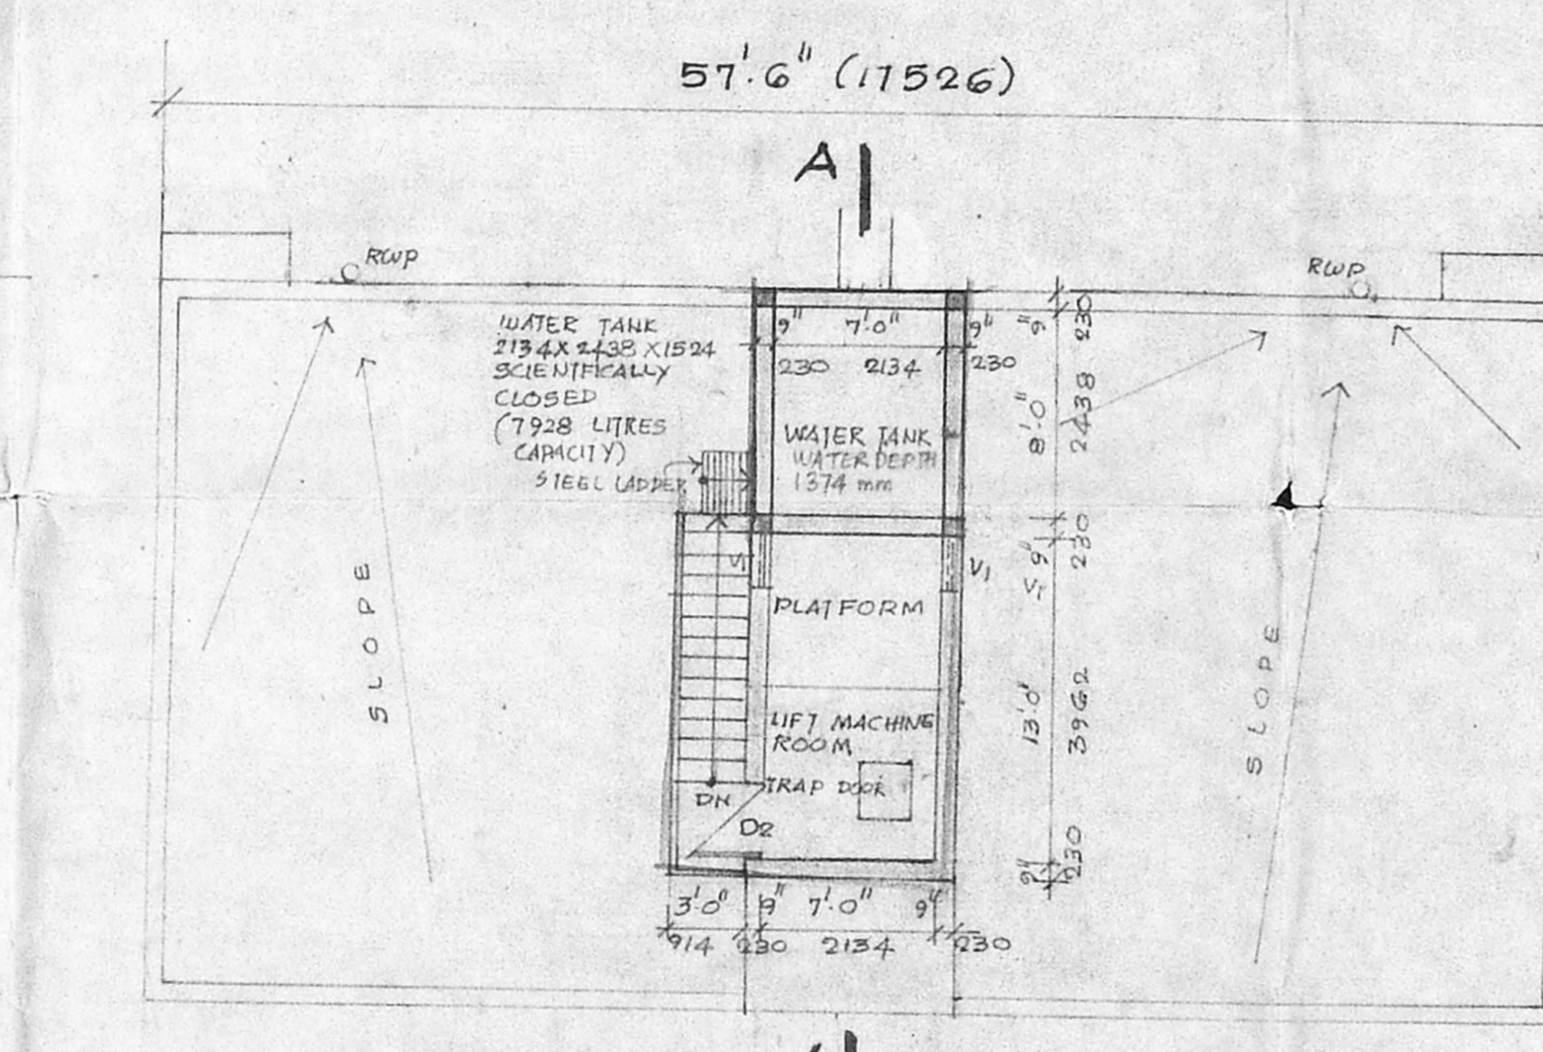


TERRACE PLAN
SCALE = 1/8" = 1'0" (1:50)

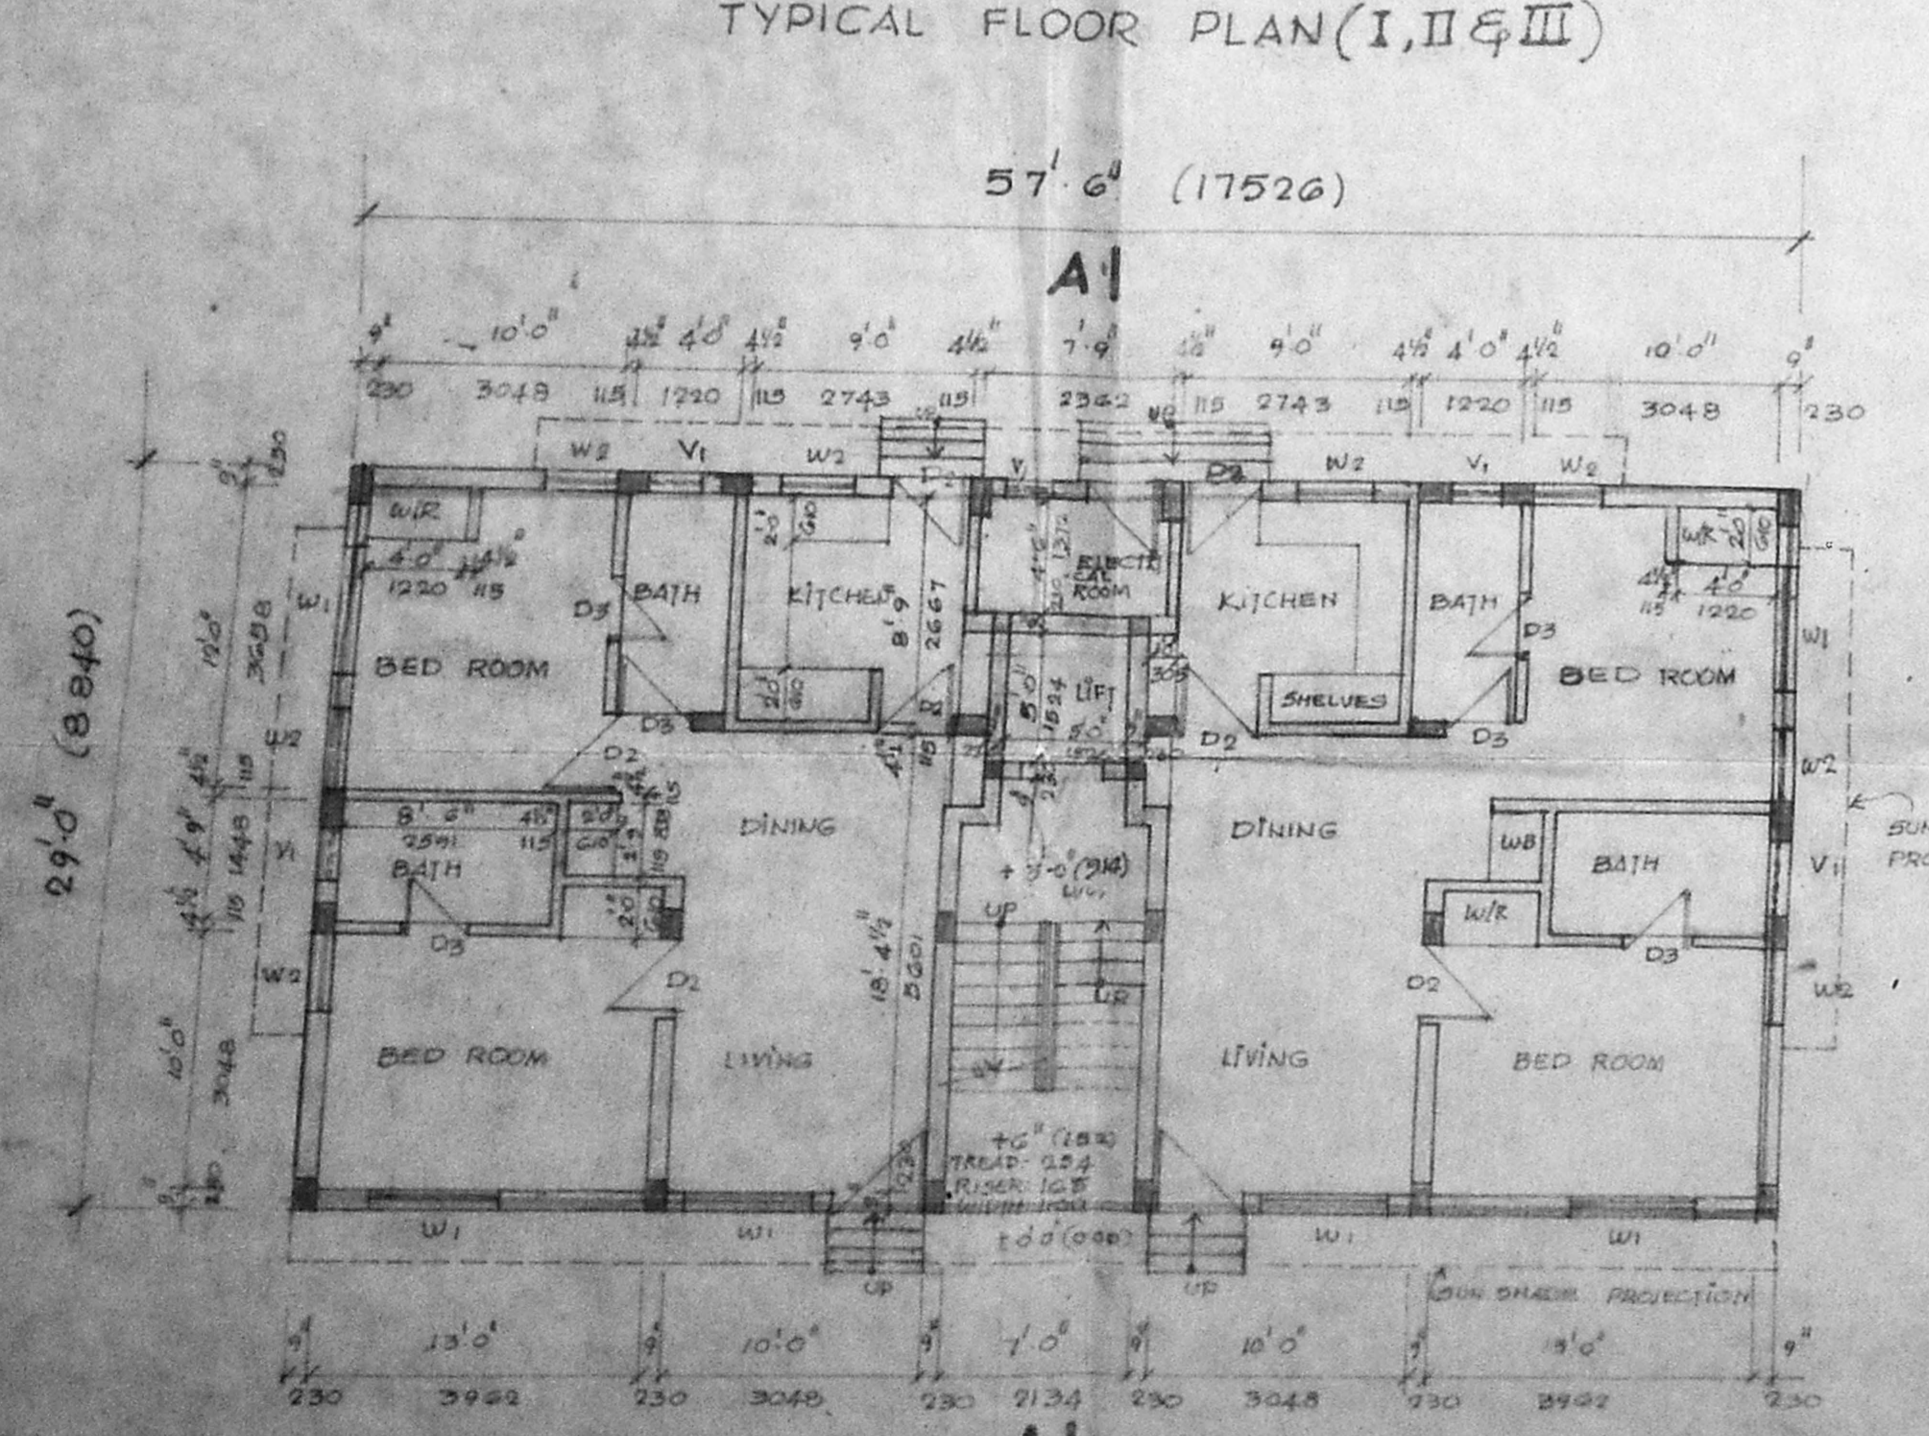


GROUND FLOOR PLAN
SCALE = 1/8" = 1'0" (1:50)

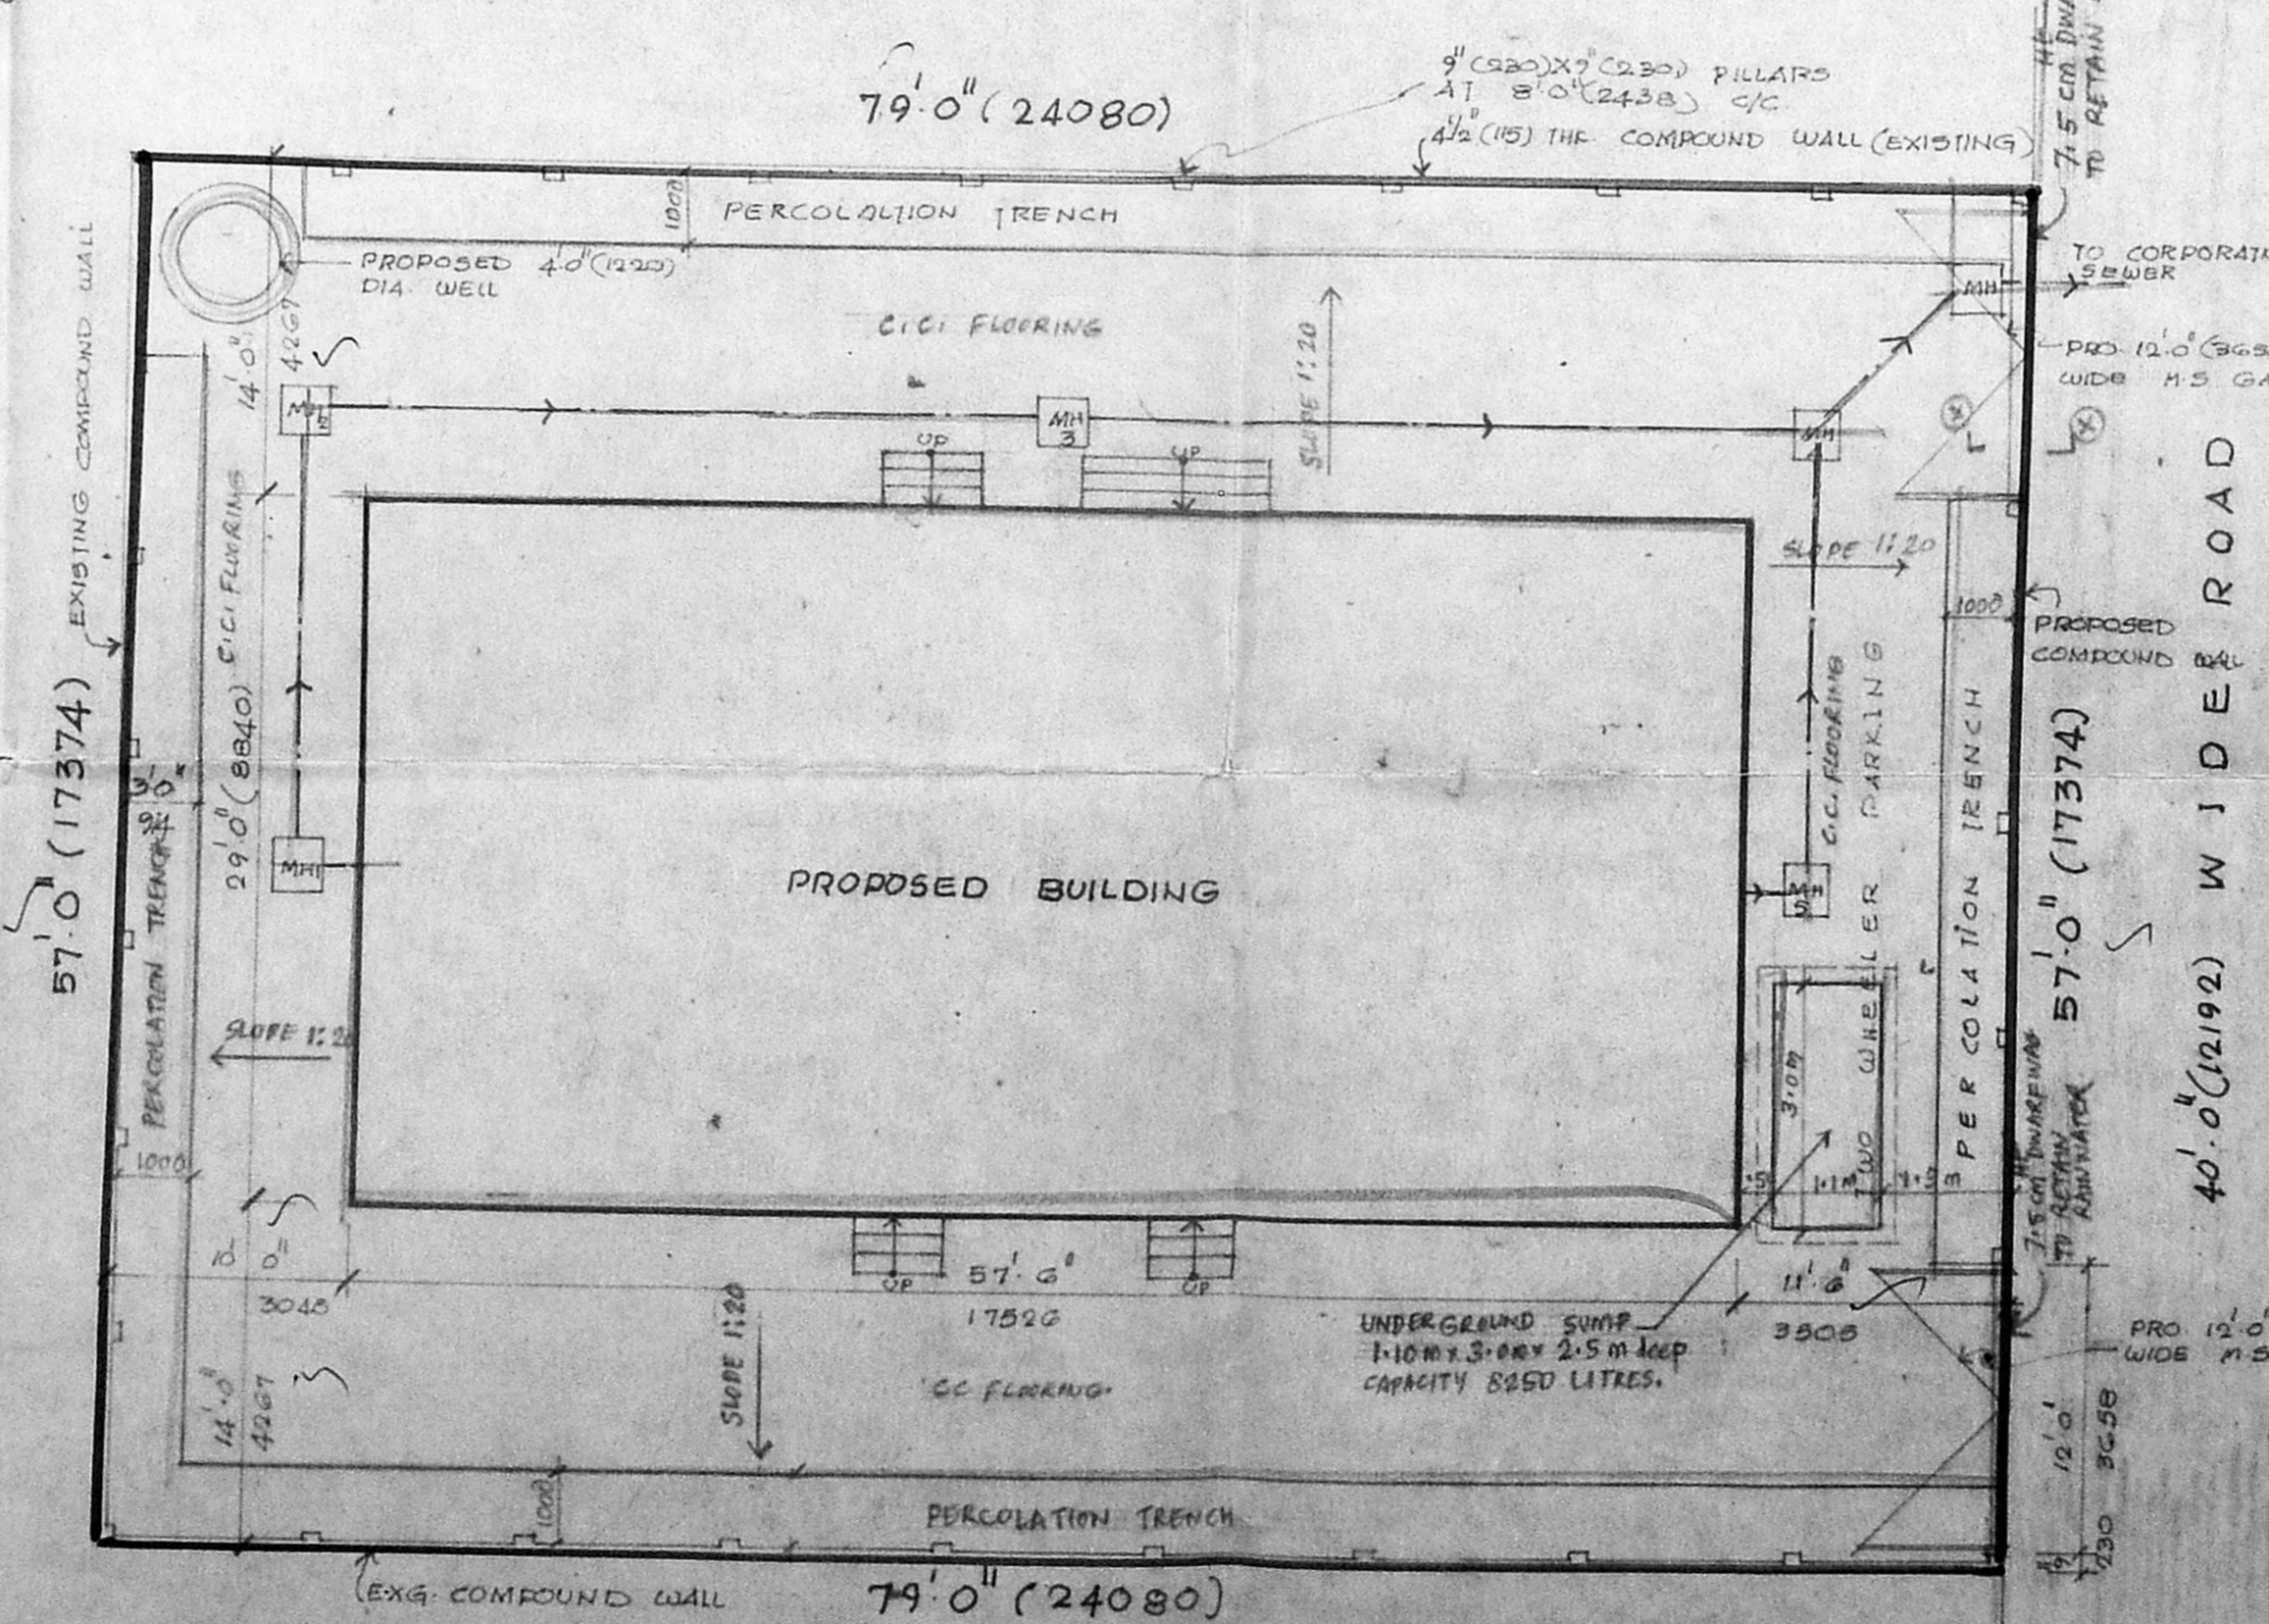

SITE PLAN
SCALE = 1/8" = 1'0" (1:50)

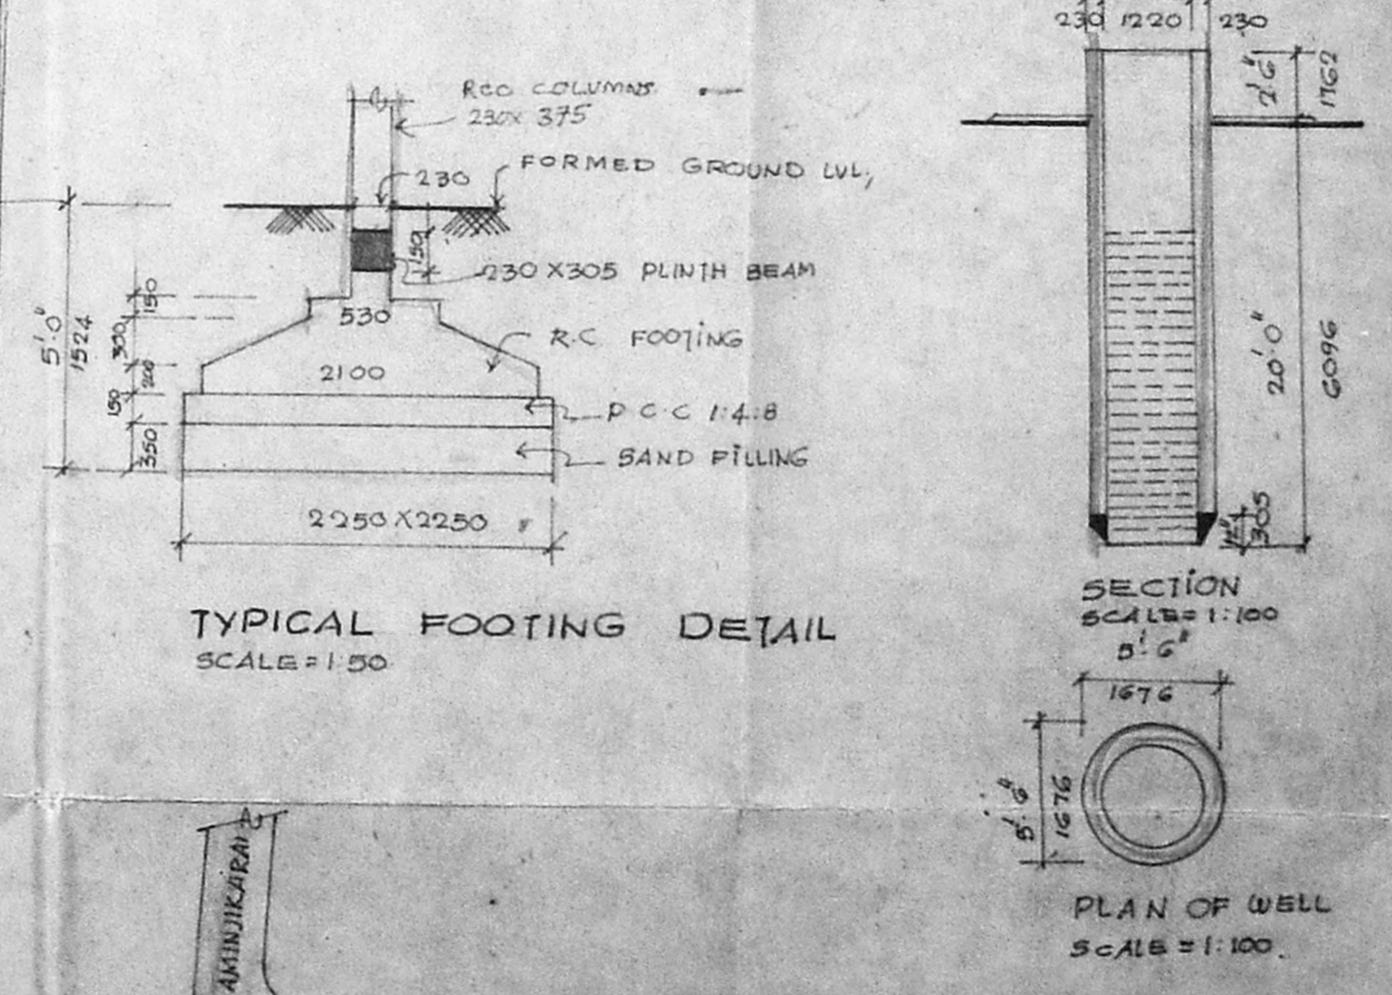

TYPICAL FOOTING DETAIL
SCALE = 1:50

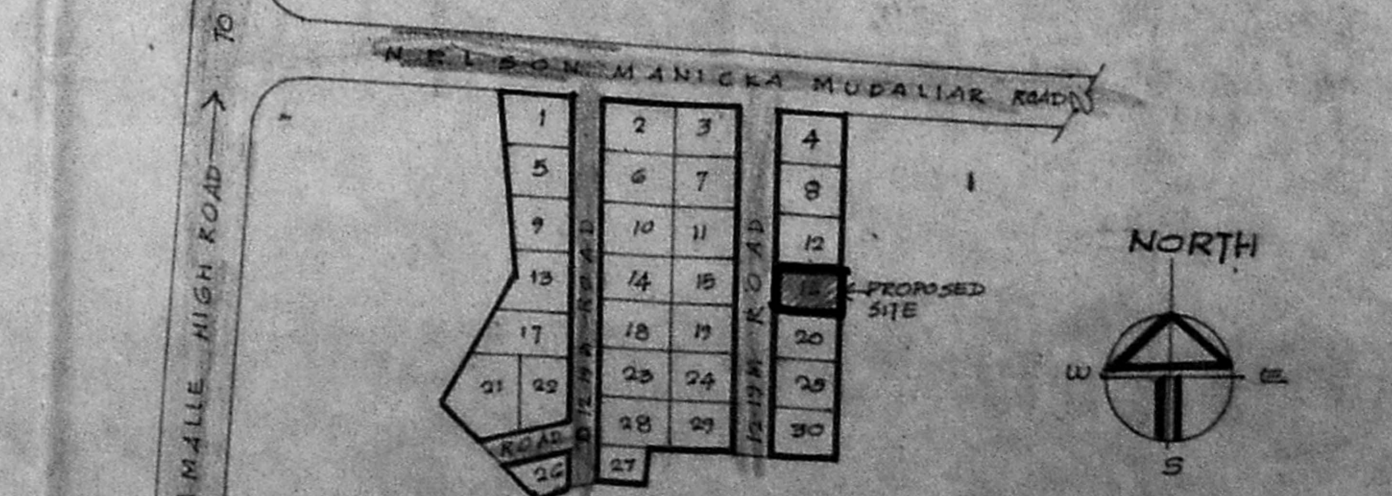

TOPO PLAN SHOWING PROPOSED PLOT NO. 16, BLOCK NO. 12, T.S. NO. 18 - G/21, SURVEY NO. 6 OF VADA AGARAM (NOT TO SCALE)